

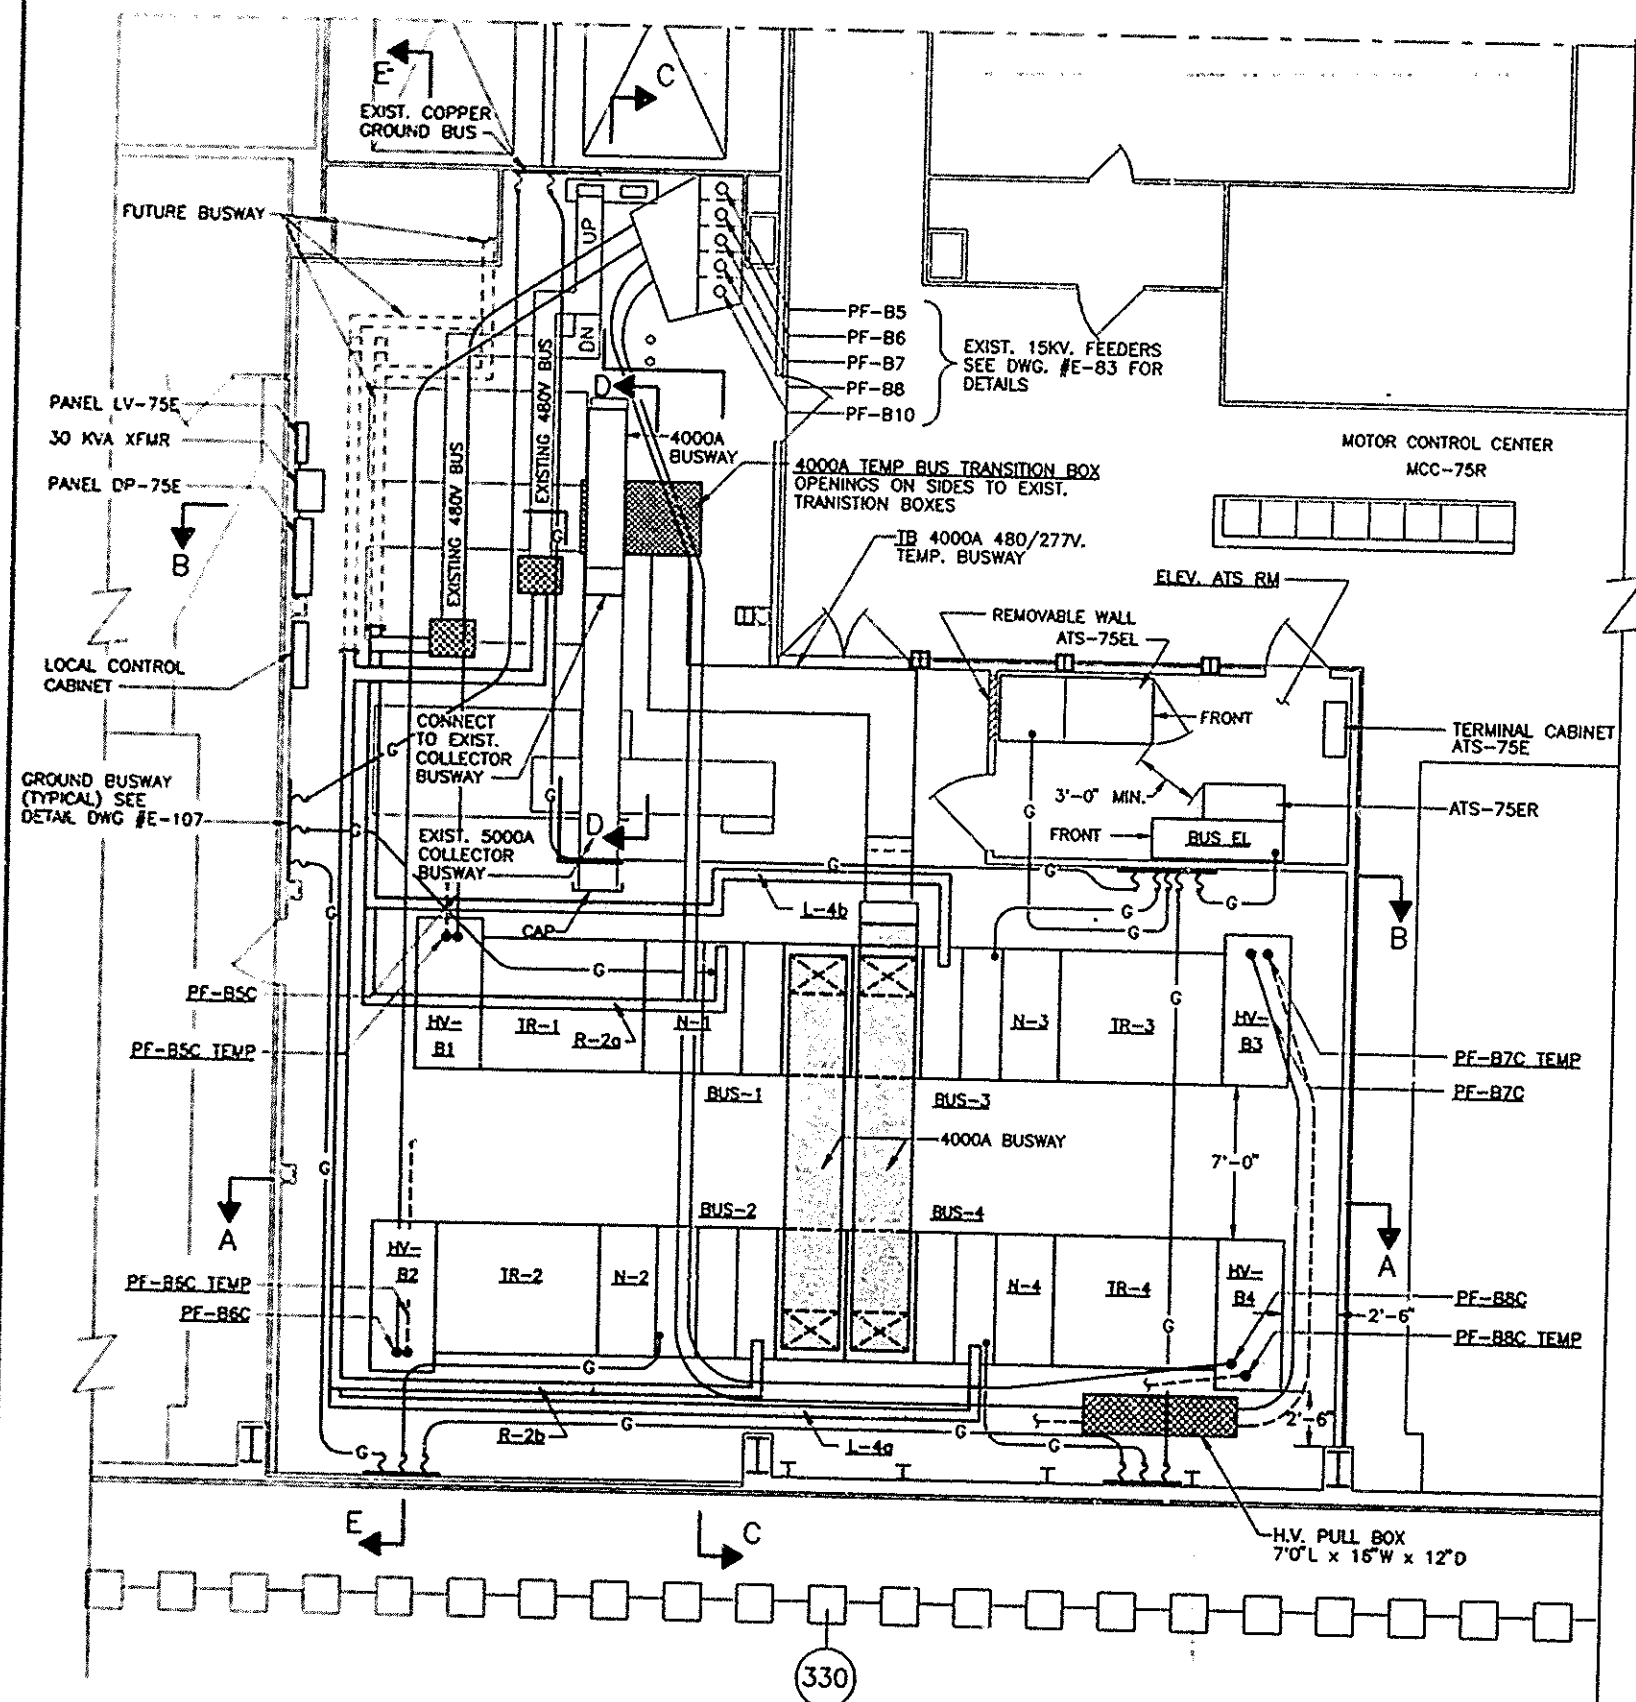



SECTION E-E

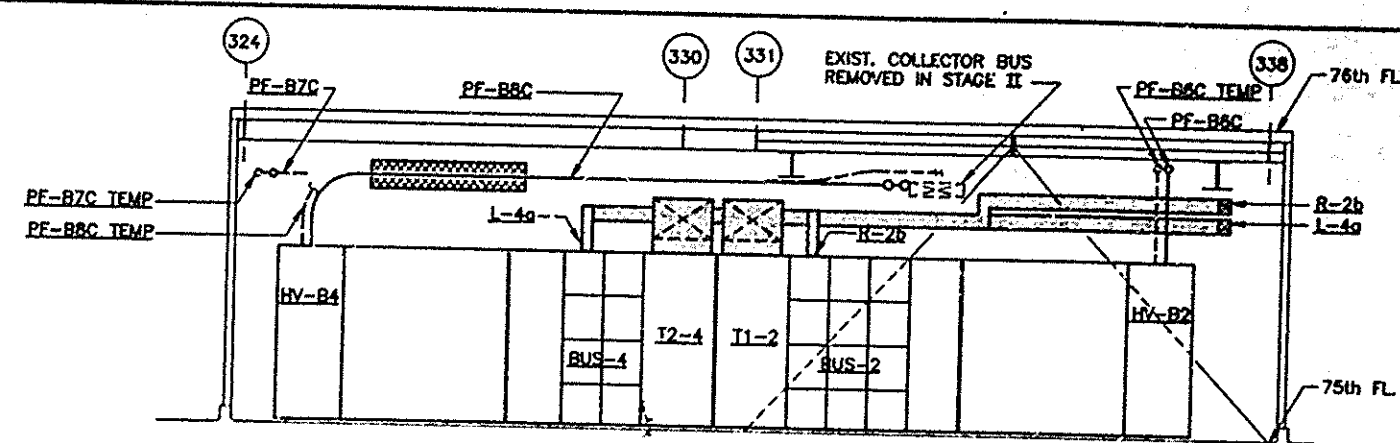


PART PLAN 75th FLOOR

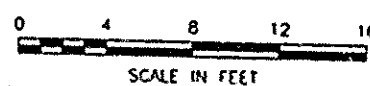


SECTION A-A

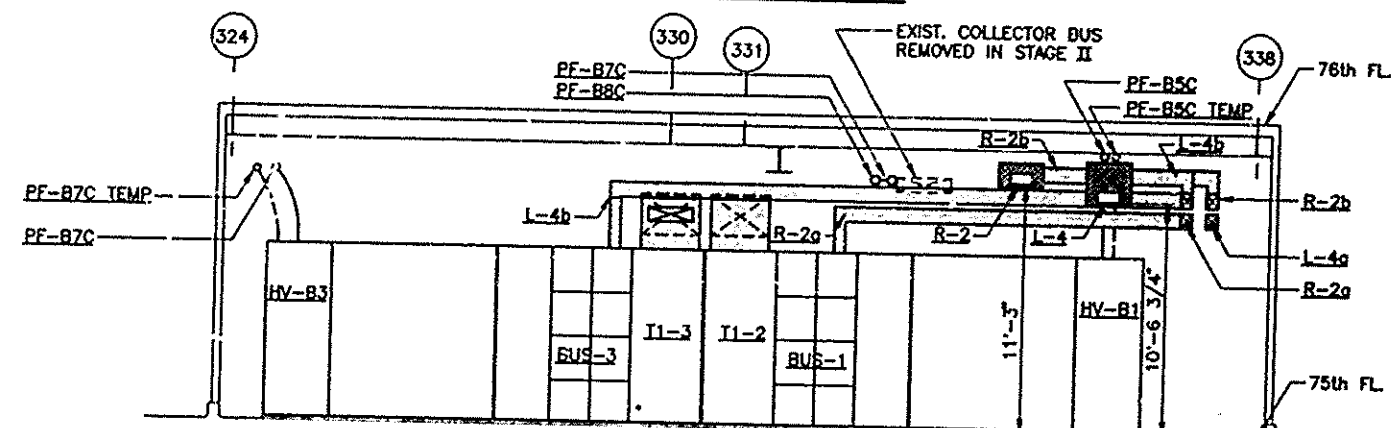

SECTION B-B

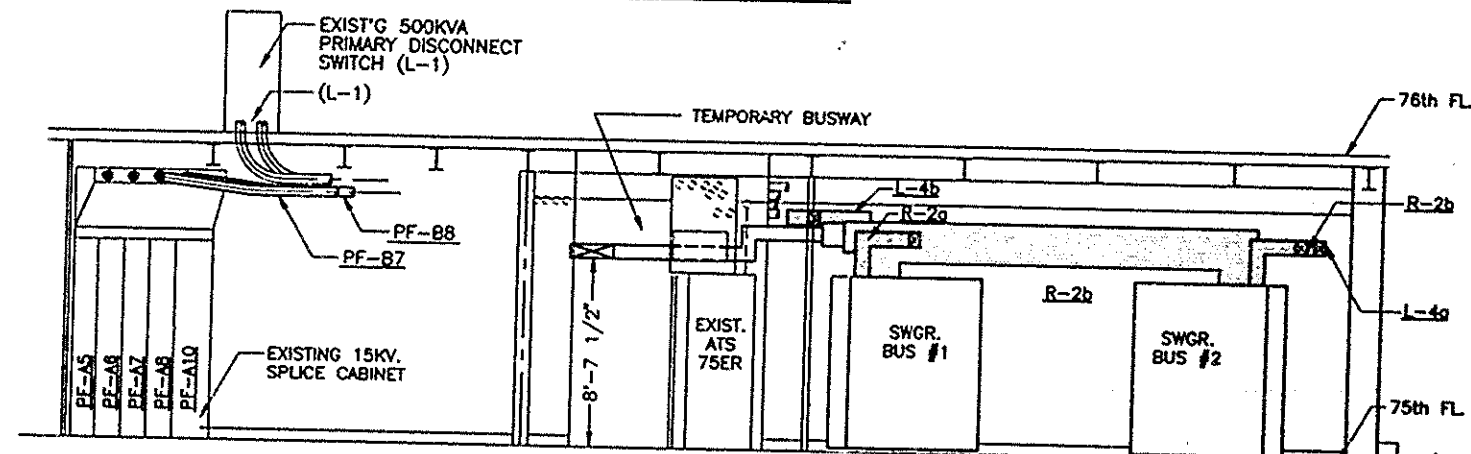

SECTION C-C

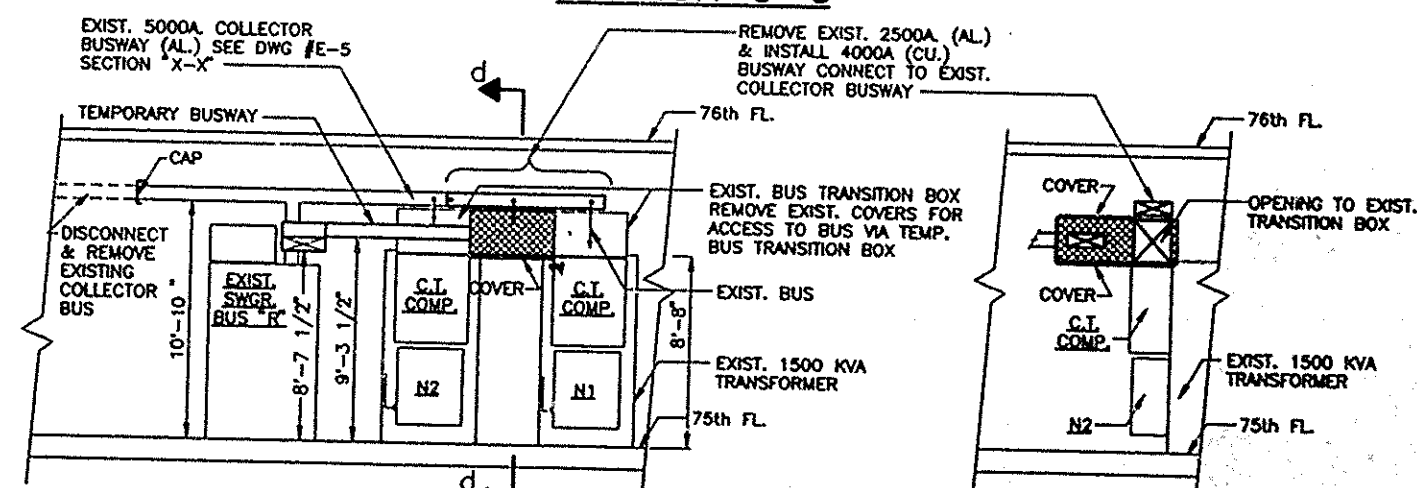

SECTION D-D

SECTION d-d

I HEREBY CERTIFY THAT THIS IS A TRUE AND CORRECT COPY OF ONE OF THE CONTRACT DRAWINGS CONSTITUTING A PART OF CONTRACT NO. WTC-802.071 IN THE FORM IN WHICH SAID DRAWINGS EXISTED AT THE TIME THE SAID CONTRACT WAS EXECUTED BY THE PARTIES.

DATE 6/21/95 *S. A. Aslam* S.E.C. WRITER

DATE 8/15/95 *Peter K. Sweeney* ENGINEER OF DESIGN

NOTE:

- THIS DRAWING SHOWS BOTH STAGE II AND III WORK COMBINED. FOR SEPARATION OF WORK SEE NOTE #3 DRAWING #E-85.
- FOR WORK IN THE ELECTRIC CLOSET "C" SEE DRAWING #E-89, SS-75W ONE LINE DIAGRAM.
- FOR LOCAL CONTROL PANEL DETAILS SEE DRAWING #E-107.
- FOR BUSWAY REQUIREMENTS SEE DWG. #E-2 GENERAL NOTE #17.

THE PORT AUTHORITY  
OF NY & NJ

*Peter K. Sweeney*  
ENGINEERING PROGRAM MANAGER  
WORLD TRADE CENTER  
*C. Fischer*  
CHIEF ELECTRICAL ENGINEER

Engineering Department  
Design Divisions

The World Trade  
Center  
Electrical/HVAC  
Upgrade Program

Title  
TOWER ONE AND TWO  
LOW VOLTAGE  
SUBSTATIONS  
CONSTRUCTION AND  
INSTALLATION

ELECTRICAL

SUBSTATION SS-75E  
STAGE II AND III  
SWITCHGEAR EQUIPMENT  
PLANS & SECTIONS

No. Date Revision Approved

This drawing subject to conditions in contract. All inventions, ideas, designs and methods herein are reserved to Port Authority and may not be used without its written consent.

LEAHY/  
FISCHER LEAHY AS

Designed by Drawn by Checked by

Date 5-1-95 Scale AS NOTED

Contract Number Drawing Number

WTC 802.071 E-86